# **APPLICANT:**

SITE ADDRESS

EL CAJON, CA 92021

PAD = 747.0

**EXISTING**:

GREG BROWN 565 N. MAGNOLIA AVENUE EL CAJON, CA 92020 TEL: (619) 281–9264

LEGEND

PROPOSED:

RIGHT-OF-WAY

**EASEMENTS** 

BUILDING SETBACKS

CUT / FILL SLOPE

PROPOSED CONTOUR

PCC BROW DITCH

EARTHEN SWALE

BROOKS BOX

SPOT ELEVATION

PAD ELEVATION

EXIST CONTOUR

EX POWER POLE

EX SEWER MAIN

EX SEWER SERVICE

EX WATER SERVICE

EX FIRE HYDRANT

RIP-RAP PER D-40

BMP BASIN

STORM DRAIN PIPE

CURB OUTLET PER D-25

RETAINING WALL PER C-2, C-3, C-4

DAYLIGHT LINE

CUT/FILL LINE

PROPOSED WATER SERVICE

PROPOSED SEWER SERVICE

GREG BROWN DATE

TERRACE HILL DRIVE

## **OWNER:**

SKY TERRACE, L.P. 1000 PIONEER WAY EL CAJON, CA 92020 TEL: (619) 977-1552

GREG BROWN DATE

## **ENGINEER OF WORK**

JONATHAN RAAB RYDEEN EXPIRES ON 6/30/19

# PRELIMINARY GRADING PLAN "TERRACE HILL DRIVE"

COUNTY OF SAN DIEGO TRACT NO. 5599

County of San Diego, California

## CUT 2:1 OR AS SPECIFIED IN SOILS REPORT FILL 2:1 OR AS SPECIFIED IN SOILS REPORT. EXCAVATION: 9,980 C.Y. FILL: 9,980 C.Y. FILL MAX HEIGHT: 12 FT

#### LEGAL DESCRIPTION

**GRADING QUANTITIES** 

THE WEST 10 ACRES OF LOT 16 IN BLOCK 16 OF THE SUBDIVISION OF THE "S" TRACT IN RANCHO EL CAJON IN THE COUNTY OF SAN DIEGO, STATE OF CALIFORNIA, ACCORDING TO MAP THEREOF IN BOOK 170, PAGE 71 OF DEEDS, FILED IN THE OFFICE OF THE COUNTY RECORDER OF SAID SAN DIEGO COUNTY. EXCEPTING THEREFROM PARCELS A AND B DESCRIBED AS FOLLOWS:

BEGINNING AT THE NORTHWEST CORNER OF SAID LOT 16; THENCE NORTH O DEG 21' 40" EAST ALONG THE NORTHERLY PROLONGATION OF THE WEST LINE OF SAID LOT. 33 FEET TO THE INTERSECTION WITH THE CENTER LINE OF PEPPER DRIVE; THENCE ALONG SAID CENTER LINE, SOUTH 89 DEG 53' 50" EAST 94.63 FEET TO AN ANGLE POINT THEREIN; THENCE CONTINUING ALONG SAID CENTER LINE, SOUTH 64 DEG 03' EAST 104.38 FEET; THENCE SOUTH O DEG 21' 40" WEST 512.48 FEET TO POINT "A": THENCE SOUTH 89 DEG 44' EAST 15 FEET: THENCE SOUTH O DEG 21' 40" WEST 160 FEET; THENCE NORTH 89 DEG 44' WEST 203.75 FEET TO THE WEST LINE OF SAID LOT: THENCE NORTHERLY ALONG SAID WEST LINE TO LINE TO THE POINT OF BEGINNING.

COMMENCING AT THE NORTHWEST CORNER OF SAID LOT 16; THENCE NORTH O DEG 21' 40" EAST ALONG THE NORTHERLY PROLONGATION OF THE WEST LINE OF SAID LOT 16, 33 FEET TO THE INTERSECTION WITH THE CENTER LINE OF PEPPER DRIVE; THENCE SOUTH 89 DEG 53' 50" EAST ALONG SAID CENTER LINE 94.63 FEET TO AN ANGLE POINT THEREIN; THENCE CONTINUING ALONG SAID CENTER LINE SOUTH 64 DEG 03' EAST 136.74 FEET TO THE TRUE POINT OF BEGINNING; THENCE CONTINUING ALONG SAID CENTER LINE, SOUTH 64 DEG 03 EAST 268.73 FEET TO THE INTERSECTION WITH THE NORTHERLY PROLONGATION OF THE EAST LINE OF THE WEST 10 ACRES OF SAID LOT 16; THENCE SOUTH 0 DEG 13' 40" WEST ALONG SAID NORTHERLY PROLONGATION AND SAID EAST LINE OF THE WEST 10 ACRES, A DISTANCE OF 325 FEET; THENCE NORTH 89 DEG 44' WEST 243.13 FEET TO AN INTERSECTION WITH A LINE WHICH BEARS SOUTH 0 DEG 21' 40" WEST FROM THE TRUE POINT OF BEGINNING; THENCE NORTH O DEG 21' 40" EAST 441.17 FEET TO THE POINT OF BEGINNING. ALSO EXCEPTING THEREFROM THAT PORTION OF LOT 16 IN BLOCK 16 OF THE SUBDIVISION OF THE "S" TRACT, IN RANCHO EL CAJON, IN THE COUNTY OF SAN DIEGO, STATE OF CALIFORNIA, ACCORDING TO MAP THEREOF IN BOOK 170, PAGE 71 OF DEEDS, FILED IN THE OFFICE OF THE COUNTY RECORDER OF SAN DIEGO COUNTY,

BEGINNING AT THE NORTHWEST CORNER OF SAID LOT 16; THENCE NORTH O DEG 21' 40" EAST ALONG THE NORTHERLY PROLONGATION OF THE WEST LINE OF SAID LOT, 33.00 FEET TO THE INTERSECTION WITH THE CENTER LINE OF PEPPER DRIVE; THENCE ALONG SAID CENTER LINE SOUTH 89 DEG 53' 50" EAST 94.63 FEET TO AN ANGLE POINT THEREIN; THENCE CONTINUING ALONG SAID CENTER LINE SOUTH 64 DEG 03' EAST 104.38 FEET; THENCE SOUTH O DEG 21' 40" WEST 512.48 FEET; THENCE SOUTH 89 DEG 44' EAST 15.00 FEET; THENCE SOUTH O DEG 21' 40" WEST 160.00 FEET; THENCE NORTH 89 DEG 44' WEST 15.00 FEET TO THE TRUE POINT OF BEGINNING: THENCE SOUTH O DEG 21' 40" WEST 98.00 FEET; THENCE NORTH 89 DEG 44' WEST 188.75 FEET MORE OR LESS TO THE WEST LINE OF SAID LOT; THENCE NORTHERLY ALONG SAID WEST LINE TO A LINE WHICH BEARS NORTH 89 DEG 44' WEST FROM THE TRUE POINT OF BEGINNING: THENCE SOUTH 89 DEG 44' EAST 188.75 FEET TO THE TRUE POINT OF BEGINNING. ALSO EXCEPTING THEREFROM THAT PORTION LYING WITHIN PARCEL MAP NO. 11467, IN THE COUNTY OF SAN DIEGO, STATE OF CALIFORNIA, FILED IN THE OFFICE OF THE COUNTY RECORDER OF SAN DIEGO COUNTY, JULY 9, 1981 AS INSTRUMENT NO. 81-216263 OF OFFICIAL RECORDS.

AN EASEMENT FOR INGRESS AND EGRESS FOR ROAD PURPOSES OVER THAT PORTION OF EXCEPTION PARCEL A WHICH LIES EAST OF A LINE BEARING SOUTH O DEG 21' 40" WEST FROM POINT "A" ABOVE DESCRIBED.

#### PARCEL 3:

AN EASEMENT FOR INGRESS AND EGRESS FOR ROAD AND UTILITY PURPOSES OVER, UNDER, ALONG AND ACROSS THOSE PORTIONS OF PARCEL MAP NO. 11467, IN THE COUNTY OF SAN DIEGO, STATE OF CALIFORNIA, FILED IN THE OFFICE OF THE COUNTY RECORDER OF SAN DIEGO COUNTY, JULY 9, 1981 AS INSTRUMENT NO. 81-216263 OF OFFICIAL RECORDS, WHICH ARE DELINEATED AND DESIGNATED ON SAID PARCEL MAP AS "PROPOSED PRIVATE ROAD EASEMENT" AND "PROPOSED PRIVATE ROAD AND UTILITY EASEMENT".

#### PARCEL 4:

AN EASEMENT FOR INGRESS AND EGRESS FOR ROAD AND UTILITY PURPOSES OVER, UNDER, ALONG AND ACROSS THOSE PORTIONS OF PARCEL MAP NO. 11467, IN THE COUNTY OF SAN DIEGO, STATE OF CALIFORNIA, FILED IN THE OFFICE OF THE COUNTY RECORDER OF SAN DIEGO COUNTY, JULY 9, 1981 AS INSTRUMENT NO. 81-216263 OF OFFICIAL RECORDS, WHICH ARE DELINEATED AND DESIGNATED ON SAID PARCEL MAP AS "PROPOSED PRIVATE ROAD AND UTILITY EASEMENT", DISCLOSED BY EASEMENT GRANT DEED RECORDED MAY 08, 2014 AS INSTRUMENT NO. 2014-0187651 OF OFFICIAL RECORDS.

APN: 400-330-30-00

### **BENCHMARK**

TOP OF CURB ON CURB RETURN AT N/W CORNER OF VIA CREST DR. & PEPPER HILL DR. RECORDED FROM: CITY OF EL CAJON VERTICAL CONTROL . ELEV: 741.098 DATUM: USC&GS

#### SOURCE OF TOPOGRAPHY

FIELD SURVEY RECEIVED JANUARY 12, 2015.



#### **VICINITY MAP** NOT TO SCALE

THOMAS BROTHERS 1232 F5

## **EASEMENTS NOTES**

ITEM #6 OF TITLE REPORT. AN EASEMENT FOR

ITEM #7 OF TITLE REPORT, AN EASEMENT FOR PRIVATE ROAD, UTILITY AND INCIDENTAL PURPOSES

**SOLAR ACCESS STATEMENT:** 

STREET LIGHT STATEMENT:

SUBDIVISION IS PROPOSING ONLY PRIVATE STREETS.

ALLOWED BY THIS SUBDIVISION.

RATE OF TIME AND MATERIALS.

ALL UNITS WITHIN THIS SUBDIVISION HAVE A MINIMUM OF 100

SQ. FT. OF SOLAR ACCESS FOR EACH FUTURE DWELLING UNIT

THE SUBDIVIDER INTENDS TO COMPLY WITH, THE STREET LIGHT REQUIREMENTS AS SPECIFIED IN THE COUNTY STANDARDS. THIS

PRELIMINARY GRADING NOTE:

THIS PLAN IS PROVIDED TO ALLOW FOR FULL AND ADEQUATE

DISCRETIONARY REVIEW OF A PROPOSED DEVELOPMENT PROJECT. THE PROPERTY OWNER ACKNOWLEDGES THAT ACCEPTANCE OR

APPROVAL OF THIS PLAN DOES NOT CONSTITUTE AN APPROVAL TO PERFORM ANY GRADING SHOWN HEREON, AND AGREES TO


PRIOR TO ISSUANCE OF ANY BUILDING PERMIT, A GEOTECHNICAL

DAMAGE TO THE PROPOSED STRUCTURE DUE TO LIQUEFACTION.


THE REVIEW OF THE TECHNICAL STUDY SHALL BE BILLED AT A

STUDY SHALL BE SUBMITTED AND APPROVED BY THE DPLU BUILDING DIVISION. THE REPORT SHALL SPECIFY FOUNDATION DESIGNS, WHICH ARE ADEQUATE TO PRECLUDE SUBSTANTIAL

OBTAIN VALID GRADING PERMISSIONS BEFORE COMMENCING

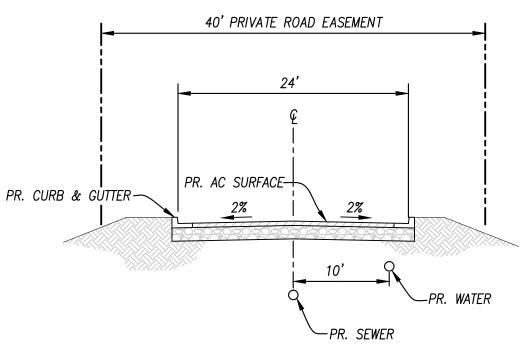


MAUZY WAY CUL-DE-SAC DRIVE (PRIVATE) 1" = 10'

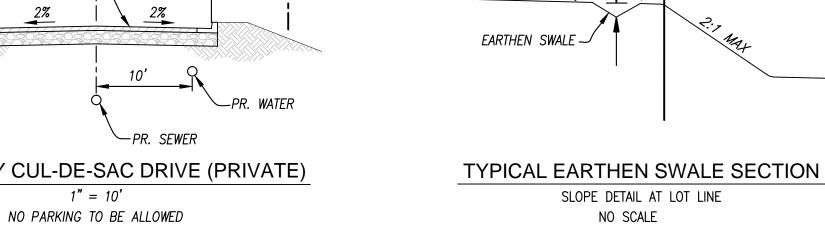


FINISHED

NO SCALE

GRADE

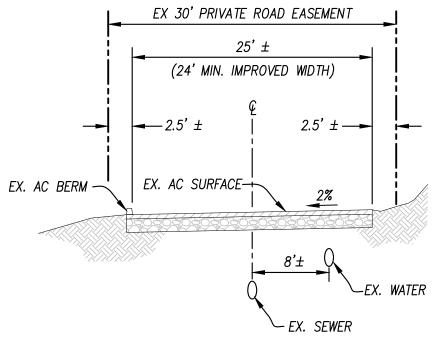

TERRACE HILL DRIVE **EXISTING SECTION (PRIVATE RD)** 1" = 10'

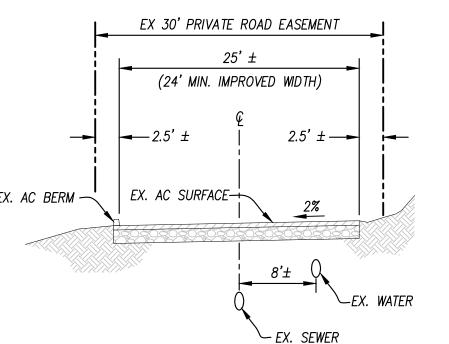


NO PARKING TO BE ALLOWED

# EXP 6/30/19

0 OUNT

SHEET NO. 1 OF 3

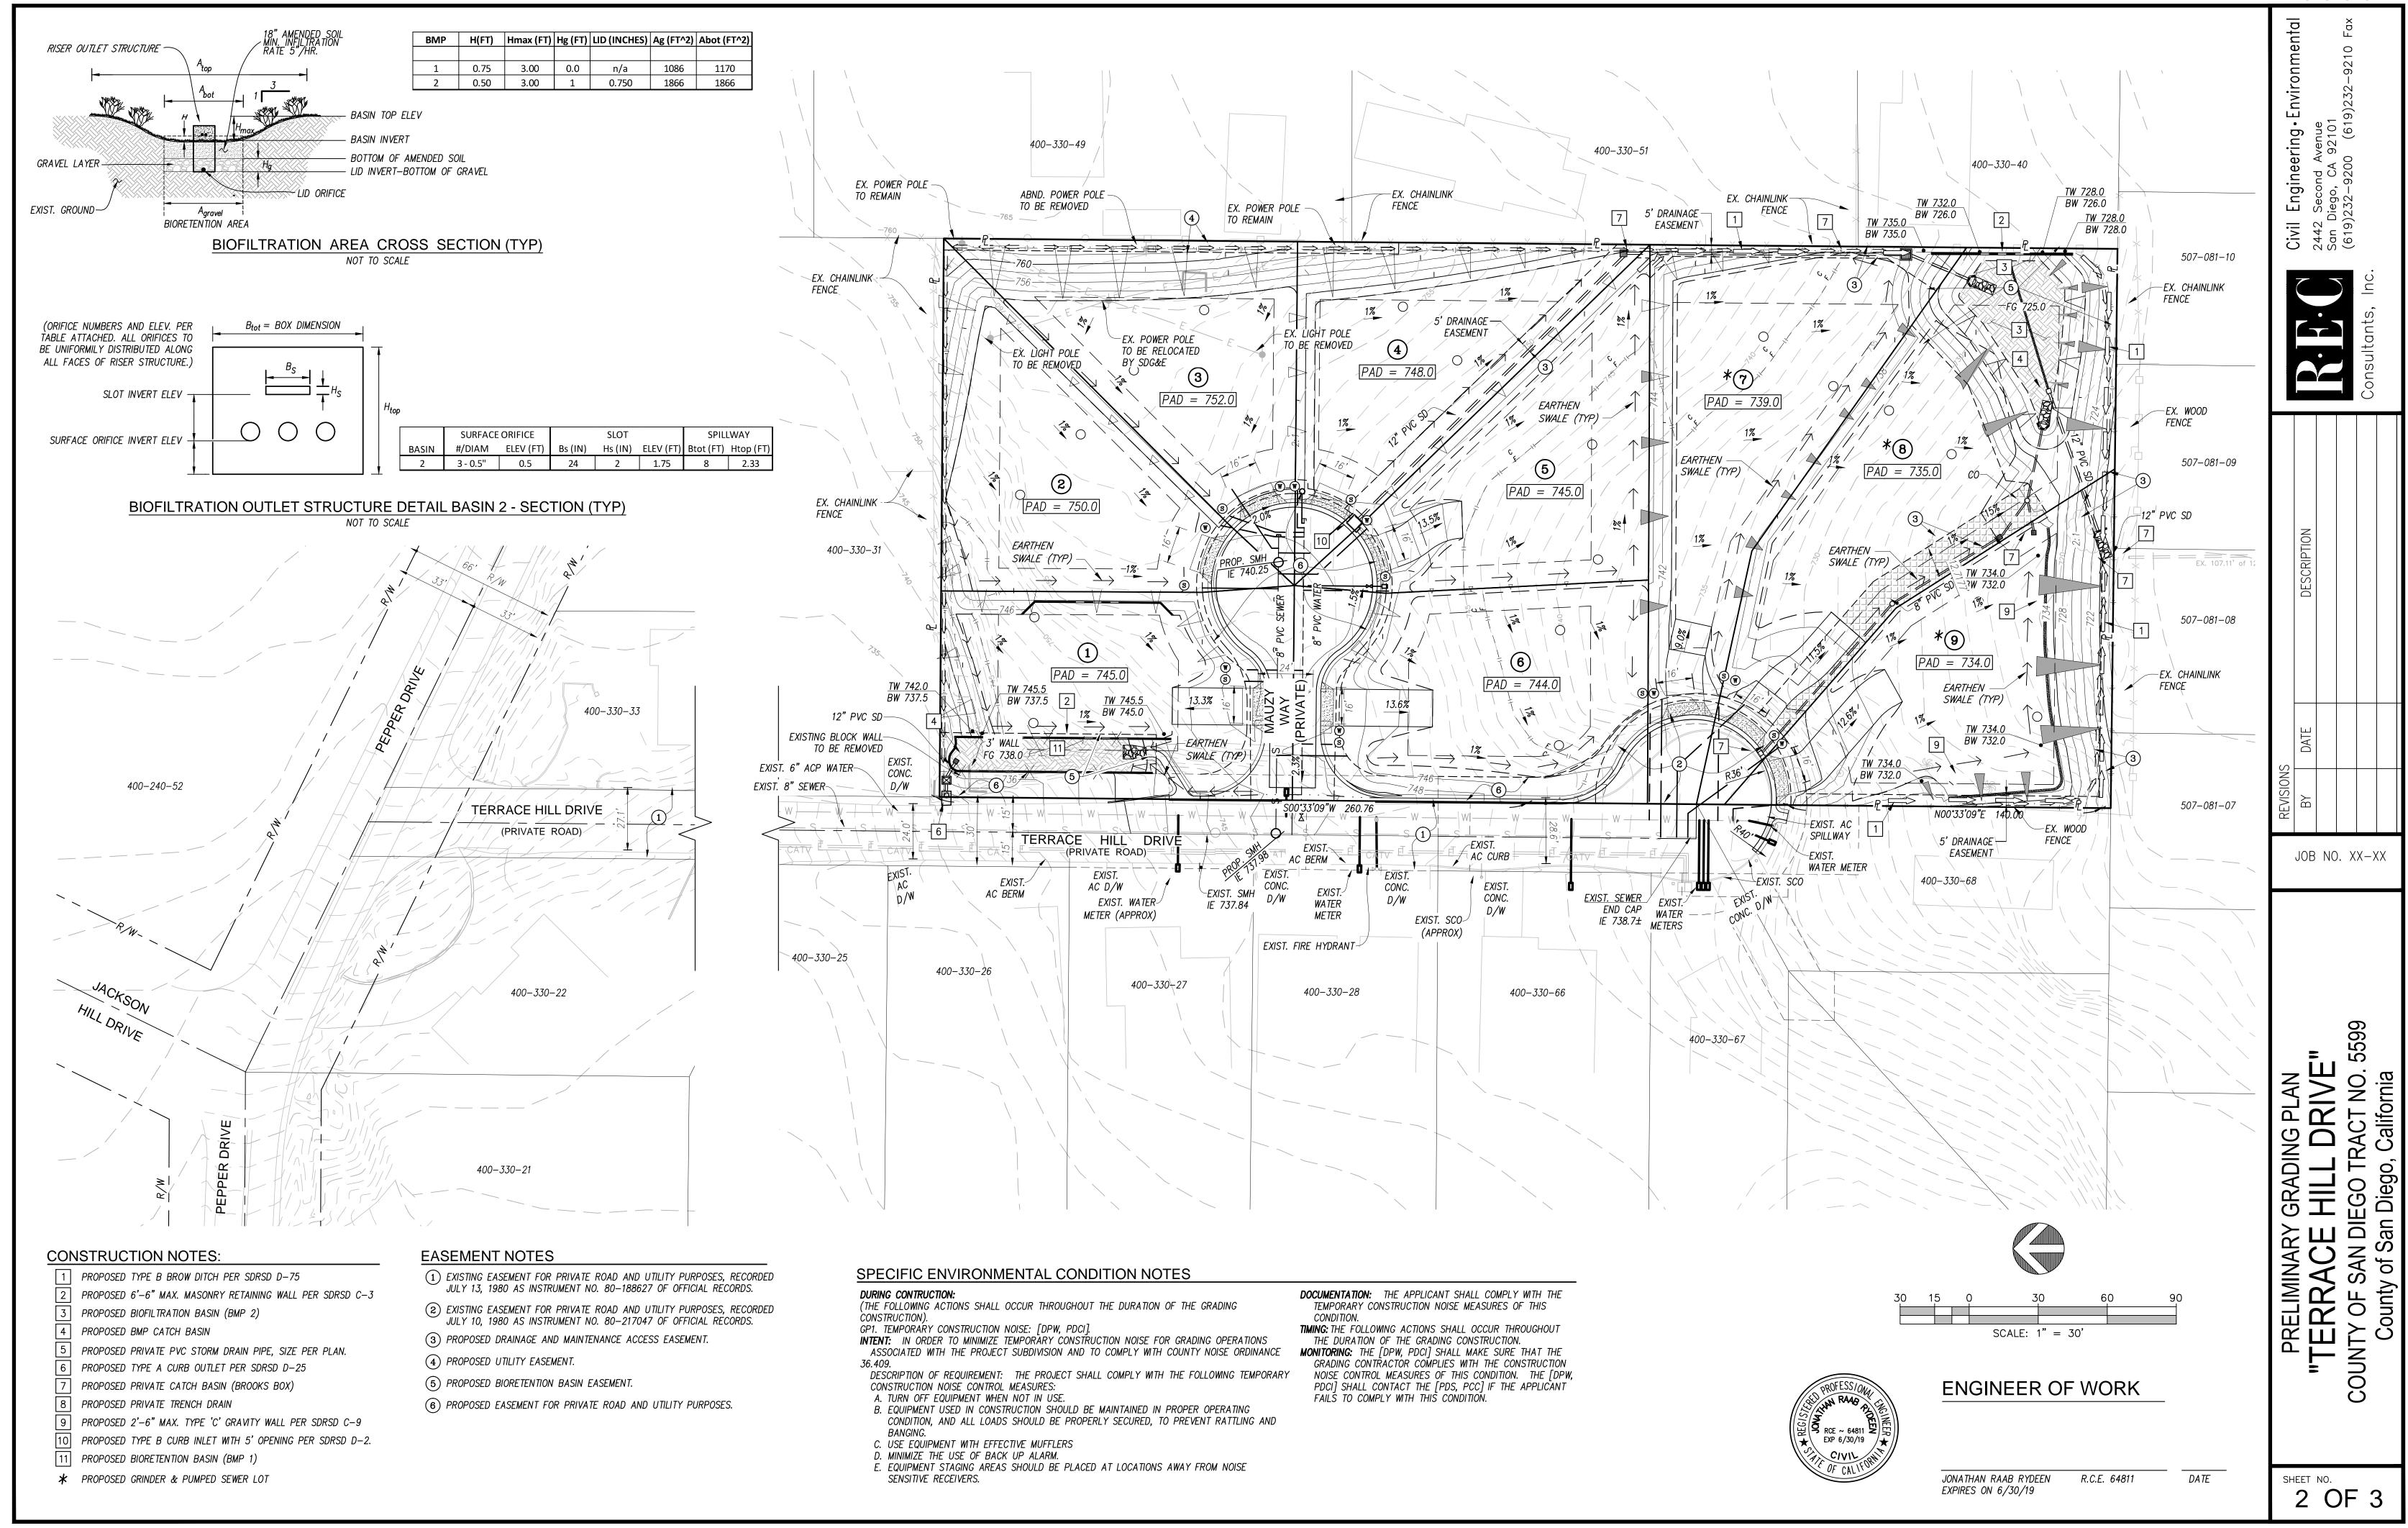

### **EROSION CONTROL NOTES**

- 1. ALL BUILDING PADS TO BE DIKED AND THE DIKES MAINTAINED TO PREVENT WATER FROM FLOWING FROM THE PAD UNTIL THE STREETS AND DRIVEWAYS ARE PAVED AND WATER CAN FLOW FROM THE PADS WITHOUT CAUSING EROSION, OR CONSTRUCT DRAINAGE FACILITIES TO THE SATISFACTION OF THE COUNTY DEPARTMENT OF PUBLIC WORKS THAT WILL ALLOW WATER TO DRAIN FROM THE PAD WITHOUT CAUSING EROSION.
- 2. TOPS OF ALL SLOPES TO BE DIKED OR TRENCHED TO PREVENT WATER FROM FLOWING OVER THE CREST OF SLOPES.
- 3. MANUFACTURED SLOPES AND PADS SHALL BE ROUNDED VERTICALLY AND HORIZONTALLY AS APPROPRIATE TO BLEND WITH THE SURROUNDING TOPOGRAPHY.
- 4. AS SOON AS CUTS OR EMBANKMENTS ARE COMPLETED, BUT NOT LATER THAN OCTOBER 1 ALL CUT AND FILL SLOPES SHALL BE STABILIZED WITH A HYDROMULCH MIXTURE OR AN EQUAL TREATMENT APPROVED BY THE COUNTY DEPARTMENT OF PUBLIC WORKS BETWEEN OCTOBER 1 AND APRIL 15. APPROVED SLOPE PROTECTION MEASURES SHALL PROCEED IMMEDIATELY BEHIND THE EXPOSURE OF CUT SLOPES AND/OR THE CREATION OF EMBANKMENT SLOPES.
- CATCH BASINS, DESILTING BASINS AND STORM DRAIN SYSTEM SHALL BE INSTALLED TO THE SATISFACTION OF THE COUNTY DEPARTMENT OF PUBLIC WORKS.
- 6. SAND BAG CHECK DAMS TO BE PLACED IN A MANNER APPROVED BY THE COUNTY DEPARTMENT OF PUBLIC WORKS IN UNPAVED STREETS WITH GRADIENTS IN EXCESS OF 2% AND ON OR IN OTHER GRADED OR EXCAVATED AREAS AS REQUIRED BY THE COUNTY DEPARTMENT OF PUBLIC WORKS.
- 7. THE DEVELOPER TO MAINTAIN THE PLANTING AND EROSION CONTROL MEASURES DES-CRIBED ABOVE UNTIL RELIEVED OF THE SAME BY THE COUNTY DEPARTMENT OF PUBLIC WORKS. THE DEVELOPER TO REMOVE ALL SOIL INTERCEPTED BY THE SAND BAGS. CATCH BASINS AND DESILTING BASINS AND KEEP THESE FACILITIES CLEAN AND FREE OF SILT AND SAND AS DIRECTED BY THE COUNTY DEPARTMENT OF PUBLIC WORKS. THE DEVE-LOPER SHALL REPAIR ANY ERODED SLOPES AS DIRECTED BY THE COUNTY DEPARTMENT OF PUBLIC WORKS.

## SILTATION AND SEDIMENT CONTROL **MEASURES NOTES**

- THE SEDIMENT BASINS SHALL BE PROVIDED AT THE LOWER END OF EVERY DRAINAGE AREA PRODUCING SEDIMENT RUNOFF. THE BASINS SHALL BE MAINTAINED AND CLEANED TO DESIGN CONTOURS AFTER EVERY RUNOFF PRODUCING STORM. THE BASINS SHOULD BE SEMI—PERMANENT STRUCTURES THAT WOULD REMAIN UNTIL SOIL STABILIZING VEGETATION HAS BECOME WELL ESTABLISHED ON ALL ERODIBLE SLOPES.
- SEDIMENTATION BASINS MAY NOT BE REMOVED OR MADE INOPERATIVE WITHOUT PRIOR APPROVAL OF THE COUNTY ENGINEER.
- SEWER OR STORM DRAIN TRENCHES THAT ARE CUT THROUGH BASIN DIKES OR BASIN INLET DIKES SHALL BE PLUGGED WITH SANDBAGS FROM TOP OF PIPE TO TOP OF DIKE.
- 4. ALL UTILITY TRENCHES SHALL BE BLOCKED AT THE PRESCRIBED INTERVALS WITH A DOUBLE ROW OF SANDBAGS WITH A TOP ELEVATION TWO SANDBAGS BELOW THE GRADED SURFACE OF THE STREET. SANDBAGS ARE TO BE PLACED WITH LAPPED COURSES. THE INTERVALS PRESCRIBED BETWEEN SANDBAG BLOCKING SHALL DEPEND ON THE SLOPE OF THE GROUND SURFACE BUT NOT TO EXCEED THE FOLLOWING:

GRADE OF THE STREET INTERVAL

OVER 10%

LESS THAN 2% AS REQUIRED 100 FEET 2% TO 4% 50 FEET 4% TO 10% 25 FEET

- 5. AFTER SEWER UTILITY TRENCHES ARE BACKFILLED AND COMPACTED, THE SURFACES OVER SUCH TRENCHES SHALL BE MOUNDED SLIGHTLY TO PREVENT CHANNELING OF WATER IN THE TRENCH AREA. CARE SHOULD BE EXERCISED TO PROVIDE FOR CROSS FLOW AT FREQUENT INTERVALS WHERE TRENCHES ARE NOT ON THE CENTERLINE OF A
- ALL BUILDING PADS SHOULD BE SLOPED TOWARDS THE DRIVEWAYS AND VELOCITY CHECK DAMS PROVIDED AT THE BASE OF ALL DRIVEWAYS DRAINING INTO THE STREET.
- 7. PROVIDE VELOCITY CHECK DAMS IN ALL UNPAVED GRADED CHANNELS AT THE INTERVALS INDICATED BELOW:

GRADE OF CHANNEL INTERVALS BETWEEN CHECK DAMS STORMWATER PROTECTION NOTES

AND COMPLETE INSTALLATION IN 48 HOURS OR LESS OF A FORECAST RAIN.

INACTIVE PERIOD.

FOR REVIEW BY COUNTY.

2. NO AREA BEING DISTURBED SHALL EXCEED 50 ACRES AT ANY GIVEN TIME WITHOUT

DEMOSTRATING TO THE SAN DIEGO COUNTY DPW DIRECTOR'S SATISFACTION THAT

THAT IS NOT ACTIVELY GRADED FOR 15 DAYS MUST BE FULLY PROTECTED FROM

3. THE PROPERTY OWNER IS OBLIGATED TO INSURE COMPLIANCE WITH ALL APPLICABLE

THAT HAVE BEEN INCORPORATED INTO THIS PLAN SHALL BE IMPLEMENTED AND

MAINTAINED TO EFFECTIVELY PREVENT THE POTENTIALLY NEGATIVE IMPACTS OF THIS

EROSION. UNTIL ADEQUATE LON-TERM PROTECTIONS ARE INSTALLED, THE DISTURBED

AREA SHALL BE INCLUDED WHEN CALCULATING THE ACTIVE DISTURBANCE AREA. ALL

EROSION CONTROL MEASURES SHALL REMAIN INSTALLED AND MAINTAINED DURING ANY

STORMWATER REGULATIONS AT ALL TIMES. THE BMP'S (BEST MANAGEMENT PRACTICES)

PROJECT'S CONSTRUCTION ACTIVITIES ON STORMWATER QUALITY. THE MAINTENANCE OF THE BMP'S IS THE PERMITTEE'S RESPONSIBILITY, AND FAILURE TO PROPERLY INSTALL OR

MAINTAIN THE BMP'S MAY RESULT IN ENFORCEMENT ACTION BY THE COUNTY OF SAN

DIEGO OR OTHERS. IF INSTALLED BMP'S FAIL, THEY MUST BE REPAIRED OR REPLACED

WITH AN ACCEPTABLE ALTERNATE WITHIN 24 HOURS, OR AS SOON AS SAFE TO DO SO.

4. ON PROJECTS OF GREATER THAN 1 ACRE ADD THE FOLLOWING NOTE: A NOTICE OF

CONTROL BOARD (SWRCB) AND THAT A STORMWATER POLLUTION PREVENTION PLAN

OF CALIFORNIA GENERAL PERMIT FOR STORMWATER DISCHARGES ASSOCIATED WITH

WITH THESE PLANS. THE NOI NUMBER ASSIGNED BY SWRCB FOR THIS PROJECT IS

(SWPPP) HAS BEEN OR WILL BE PREPARED IN ACCORDANCE WITH THE REQUIREMENTS

CONSTRUCTION ACTIVITY (PERMIT NO. CASOOOOO2) FOR ALL OPERATIONS ASSOCIATED

[WDID#] [ALTERNATIVE: NOT YET ASSIGNED, BUT WILL BE PROVIDED BEFORE A PERMIT IS

THE PERMITTEE SHALL KEEP A COPY OF THE SWPPP ON SITE AND AVAILABLE

INTENT (NOI) HAS BEEN, OR WILL BE FILED WITH THE STATE WATER RESOURCES

1. DURING THE RAINY SEASON THE AMOUNT OF EXPOSED SOIL ALLOWED AT ONE TIME SHALL

THE EVENT OF A RAINSTORM. 125% OF ALL SUPPLIES NEEDED FOR BMP MEASURES

SHALL BE RETAINED ON THE JOB SITE IN A MANNER THAT ALLOWS FULL DEPLOYMENT

NOT EXCEED THAT WHICH CAN BE ADEQUATELY PROTECTED BY THE PROPERTY OWNER IN

ADEQUATE EROSION AND SEDIMENT CONTROL CAN BE MAINTAINED. ANY DISTURBED AREA

LESS THAN 3% 100 FEET 50 FEET 3% TO 6% 25 FEET OVER 6%


- 8. PROVIDE VELOCITY CHECK DAMS IN ALL PAVED STREET AREAS ACCORDING TO RECOM-MENDED CRITERIA INDICATED ON THE ENCLOSED GRAPH ENTITLED "SANDBAG BARRIER SPACING FOR EROSION CONTROL IN GRADED STREETS". VELOCITY CHECK DAMS MAY BE CONSTRUCTED OF SANDBAGS, TIMBAR, OR OTHER EROSION RESISTANT MATERIALS APPROVED BY THE COUNTY ENGINEER, AND SHALL EXTEND COMPLETELY ACROSS THE STREET OR CHANNEL AT RIGHT ANGLES TO THE CENTERLINE. VELOCITY CHECK DAMS MAY ALSO SERVE AS SEDIMENT TRAPS.
- 9. PROVIDE A SANDBAG SILT BASIN OR TRAP BY EVERY STORM DRAIN INLET TO PREVENT SEDIMENT FROM ENTERING DRAIN SYSTEM.
- 10. SANDBAGS AND FILL MATERIAL SHALL BE STOCKPILED AT INTERVALS, READY FOR USE WHEN REQUIRED.
- 11. ALL EROSION CONTROL DEVICES WITHIN THE DEVELOPMENT SHOULD BE MAINTAINED DURING AND AFTER EVERY RUNOFF PRODUCING STORM, IF POSSIBLE, MAINTENANCE CREWS WOULD BE REQUIRED TO HAVE ACCESS TO ALL AREAS.
- 12. PROVIDE ROCK RIPRAP ON CURVES AND STEEP DROPS IN ALL EROSION PRONE DRAINAGE CHANNELS DOWNSTREAM FROM THE DEVELOPMENT. THIS PROTECTION WOULD REDUCE EROSION CAUSED BY THE INCREASED FLOWS THAT MAY BE ANTICIPATED FROM DENUDED SLOPES, OR FROM IMPERVIOUS SURFACES.
- 13. ANY PROPOSED ALTERNATE CONTROL MEASURES MUST BE APPROVED IN ADVANCE BY ALL RESPONSIBLE AGENCIES: I.E., COUNTY ENGINEER, DEPARTMENT OF SANITATION AND FLOOD CONTROL, OFFICE OF ENVIRONMENTAL MANAGEMENT, ETC.

EXPIRES ON 6/30/19





#### **ENGINEER OF WORK**


JONATHAN RAAB RYDEEN R.C.E. 64811 DATE

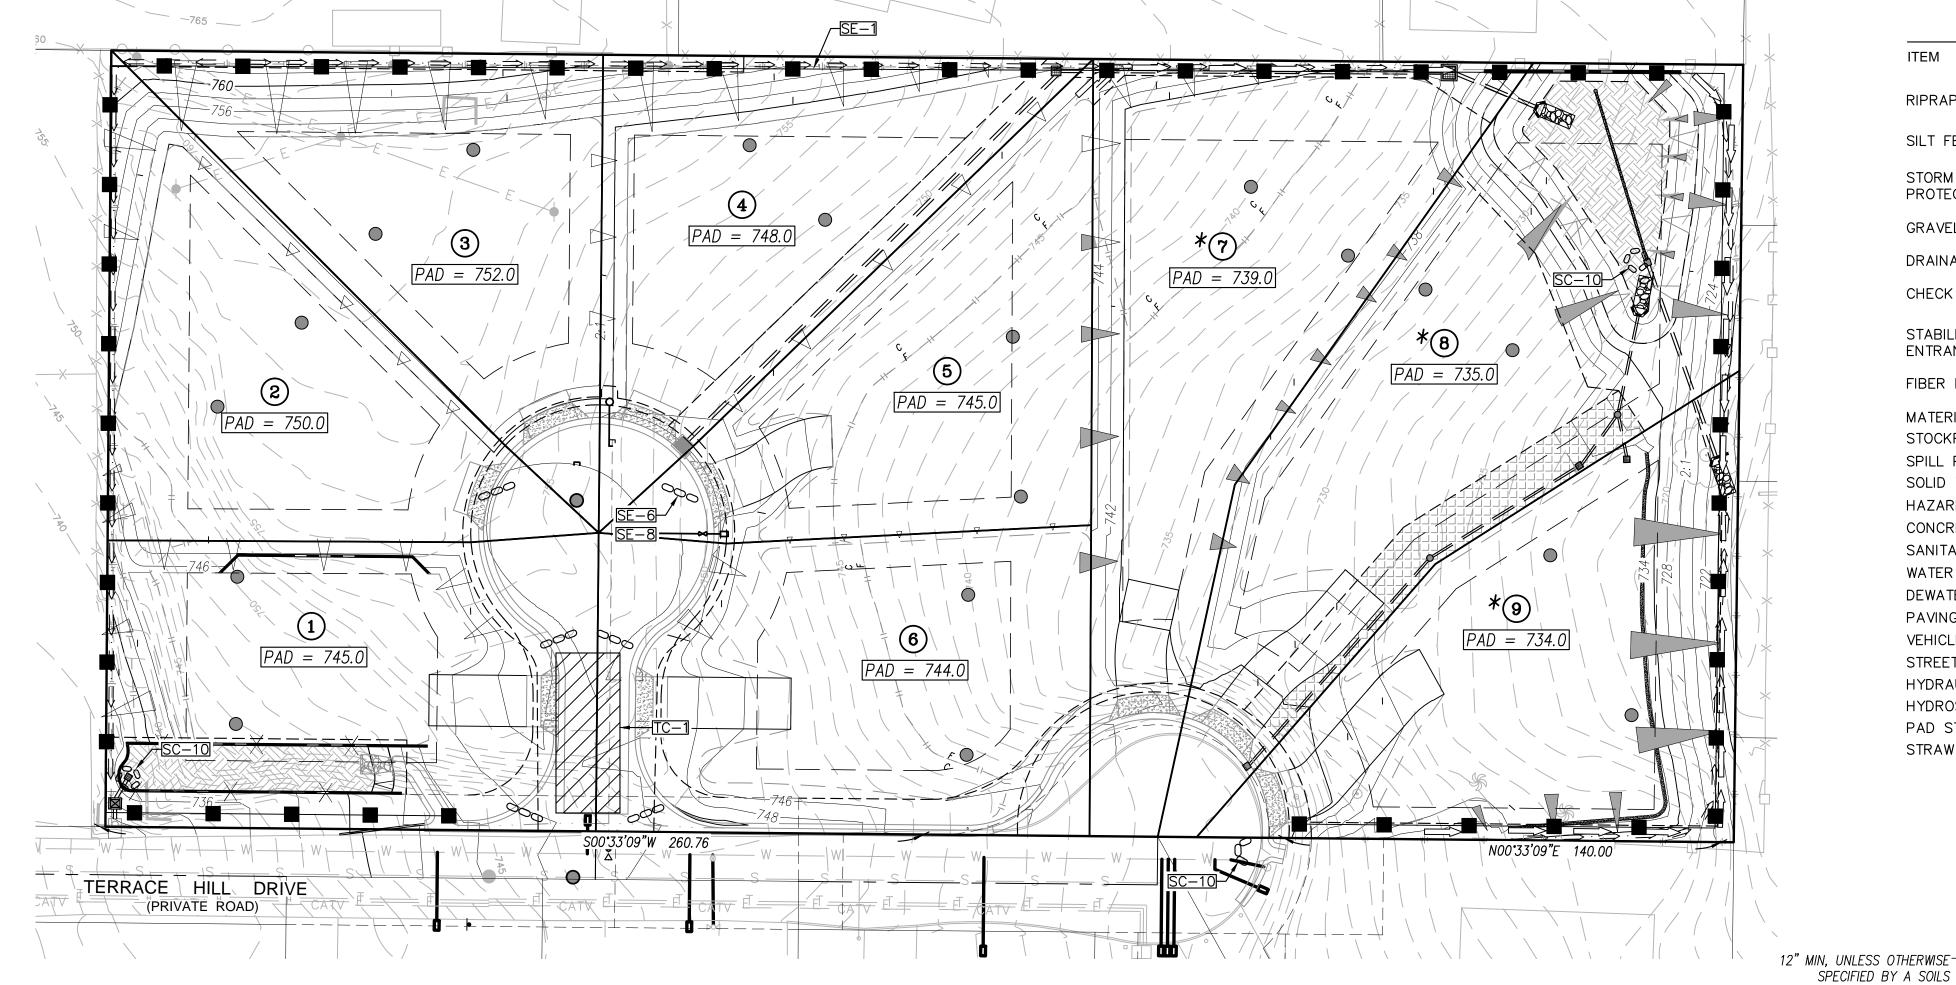


1. SET POSTS AND EXCAVATE A 4 BY 4 2. STAPLE WIRE FENCING TO THE IN (10 BY 10 CM) TRENCH UP SLOPE FROM AND ALONG THE LINE OF POSTS. 3. ATTACH THE FILTER FABRIC TO THE 4. BACKFILL AND COMPACT THE WIRE FENCE AND EXTEND IT INTO THE EXCAVATED SOIL.

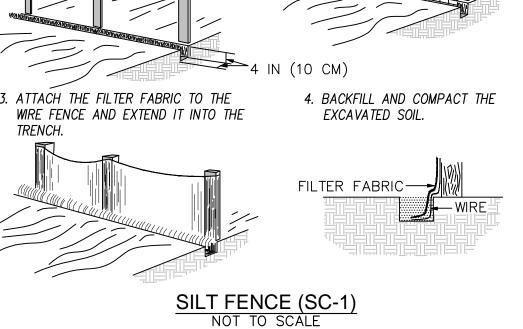


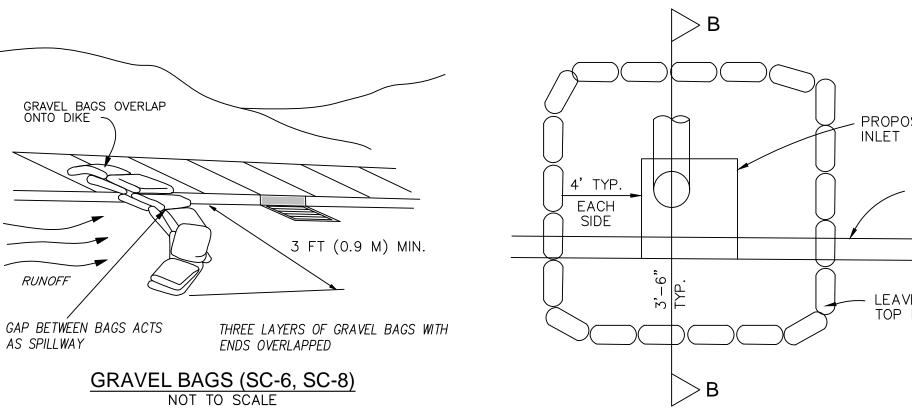

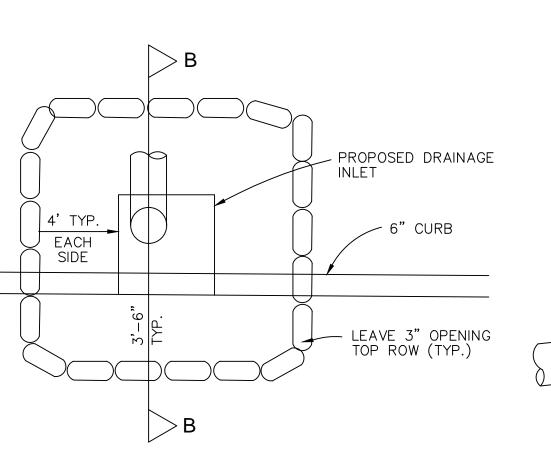

STORM DRAIN INLET PROTECTION (SC-10) NOT TO SCALE

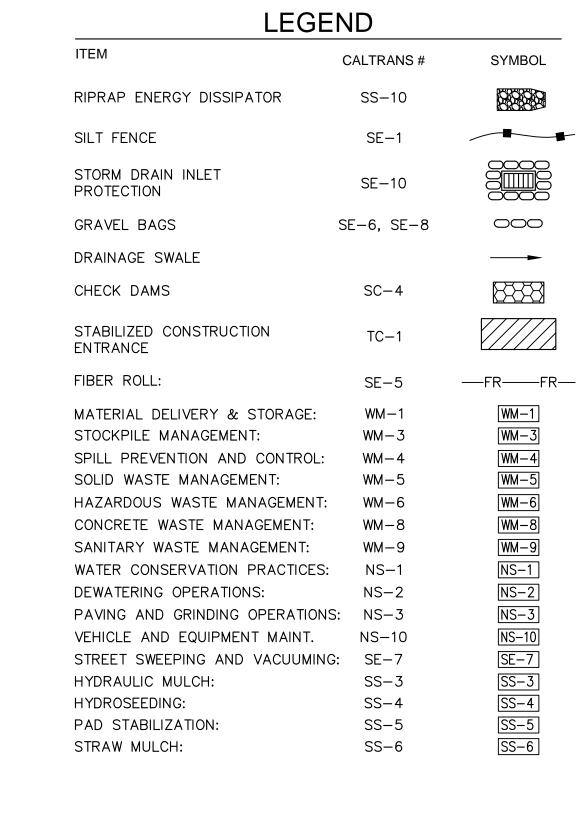

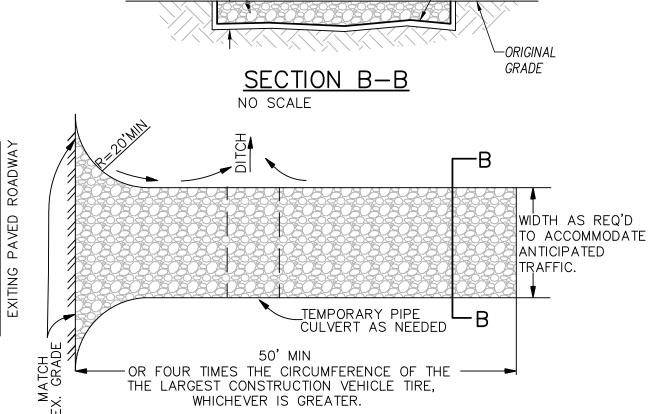

BUT SMALLER THAN 6"

SPECIFIED BY A SOILS

ENGINEER


\_CRUSHED AGGREGATE GREATER THAN 3",

FILTER FABRIC

STABILIZED CONSTRUCTION ENTRANCE (TC-1)

RUNOFF TO SEDIMENT TRAPPING DEVICE.


CONSTRUCTION SEDIMENT BARRIER AND CHANNELIZE

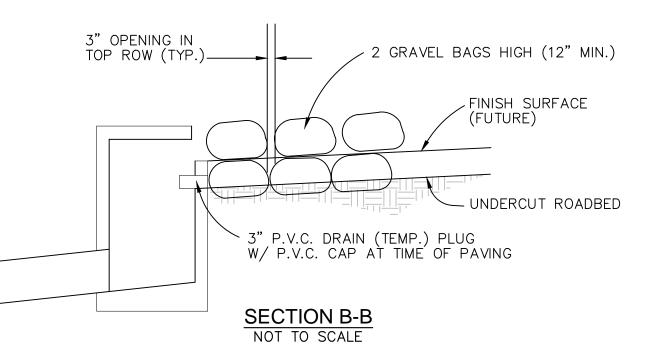

1. PRIOR TO FINAL GRADING INSPECTION, CLEAN ALL EXIST. P.C.C. DITCHES AND REPAIR AS REQUIRED BY COUNTY INSPECTOR.

En ring Civil 2442 San [619]



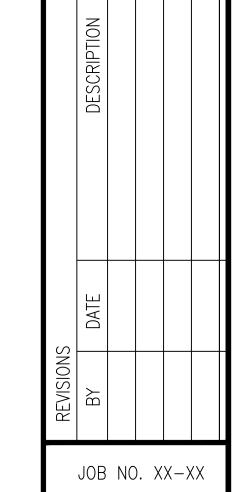

2 JG PLAN DRIVE RACT NO. { DING

CE N DI RELIMINARY ERRACE S 0 . N N O

SHEET NO. 3 OF 3